
# PHASED CONSTRUCTION SEQUENCE & FACILITY MODIFICATIONS ODNR CHIEF'S ORDER #2014-183 WEAVERTOWN TRANSPORT LEASING, INC. WTL PROCESSING FACILITY GRANDVIEW TOWNSHIP, WASHINGTON COUNTY, OHIO

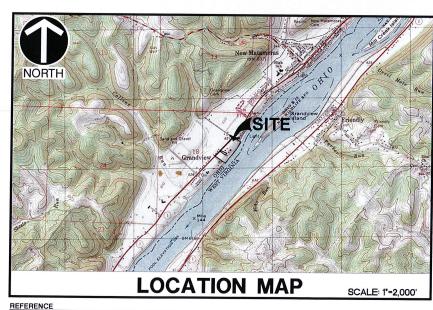



PREPARED FOR:



APPLICANT/OWNER/OPERATOR
WEAVERTOWN TRANSPORT LEASING, INC.
2 DORRINGTON ROAD
CARNEGIE, PENNSYLVANIA 15106

PREPARED BY:

Civil & Environmental

Consultants, Inc. 8740 ORION PLACE, SUITE 100 COLUMBUS, OHIO 43240

OCTOBER 2014 CEC PROJECT NO. 112-048

		CUDALITAL DECORD	
		SUBMITTAL RECORD	
NO	DATE	DESCRIPTION	
		REVISION RECORD	
NO	DATE	DESCRIPTION	
-			

ENGINEER/SURVEY
CML & ENWRONMENTAL CONSULTANTS, INC.
8740 ORION PLACE, SUITE 100
COLUMBUS, OHIO 43240
REPAIRER: ROY A. STANLEY, PROJECT MANAGI
PHONE: 814-854-6833

DEVELOPER
WEAVERTOWN TRANSPORT LEASING, INC.
2 DORRINGTON ROAD
CARNEGIE, PENNSYLVANIA 15106
REPRESENTATIVE: DARYL HEISER, VICE PRESIDE!
PHONE: 724-746-4850

RECEIVED

OCT 02 2014

Division of Oil and Gas Resources Management

DRAWING INDEX							
SHEET NO.	DWG. DESC.	SHEET TITLE					
1	1	TITLE SHEET					
2	2	SITE ENVIRONS					
3	3A	SITE LAYOUT PHASE 1					
4	38	SITE LAYOUT PHASE 2					
5	3C	SITE LAYOUT PHASE 3					
6	3D	SITE LAYOUT PHASE 4					
7	3E	PROCESSING FACILITY BUILDING PLAN					
8	3F	PROCESSING FACILITY SECTION VIEWS					
9	3G	MISCELLANEOUS DETAILS					
10	3H	EROSION CONTROL PLAN - NORTH FACILITY					
11	31	EROSION CONTROL PLAN - SOUTH FACILITY					
12	3J	EROSION CONTROL NOTES AND DETAILS					

STANDARD DRAWINGS

ODOT

ODOT TYPE CATCH BASIN 2-2A (MODIFIED)

ODOT TYPE HALF-HEIGHT HEADWALL 2-1

THE STANDARD CONSTRUCTION DRAWINGS LISTE
ON THESE PLANS SHALL BE CONSIDERED A PA

\*HAND SIGNATE

Civil & Environmental Consultants, Inc. 8740 Orion Place, Suite 100 - Columbus, OH 43240 Ph: 614.540.6633 - 888.598.6808 - Fax: 614.540.6638

PHASED CONSTRUCTION SEQUENCE & FACILITY MODIFICATIONS ODNR CHIEF'S ORDER #2014-183 WEVERTOWN TRANSPORT LEASING, INC.


BY: NAS CHECKED BY: RAS APPROVED BY:


OCTOBER 2014 DWG SCALE: AS SHOWN PROJECT NO:


TITLE SHEET


1


1. U.S.G.S TOPOGRAPHIC MAP, NEW MATAMORAS QUADRANGLE, OHIO & WEST VIRGINIA DATED: 1979

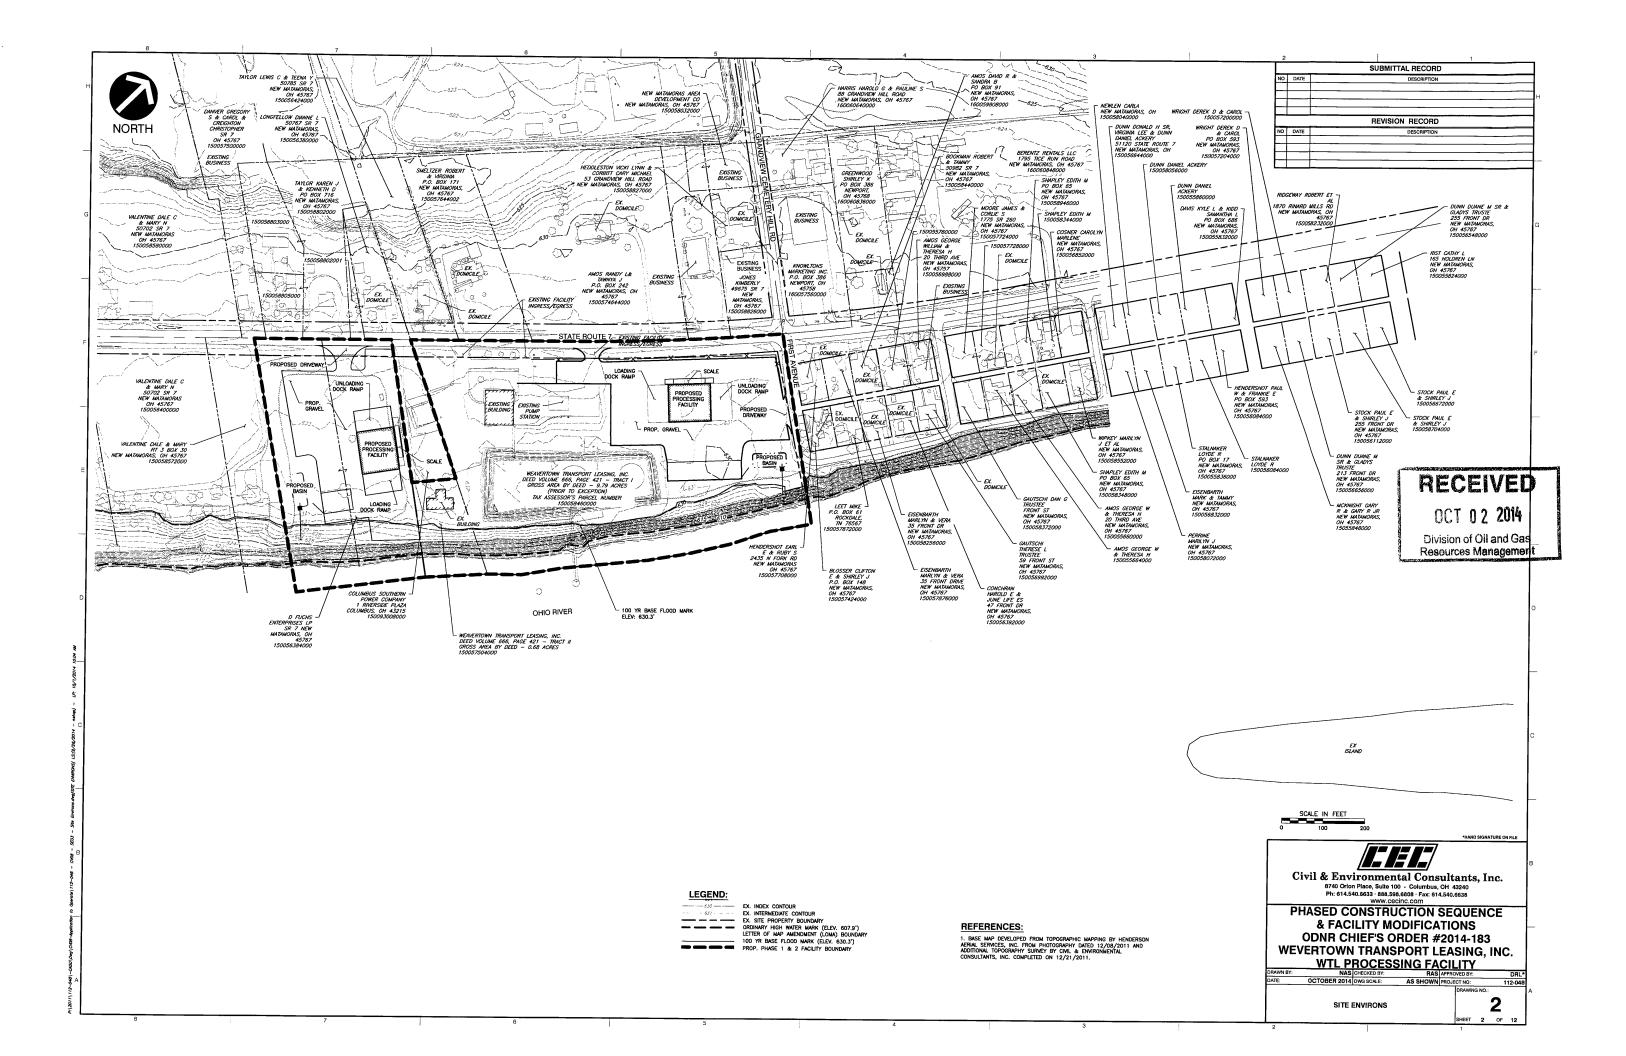

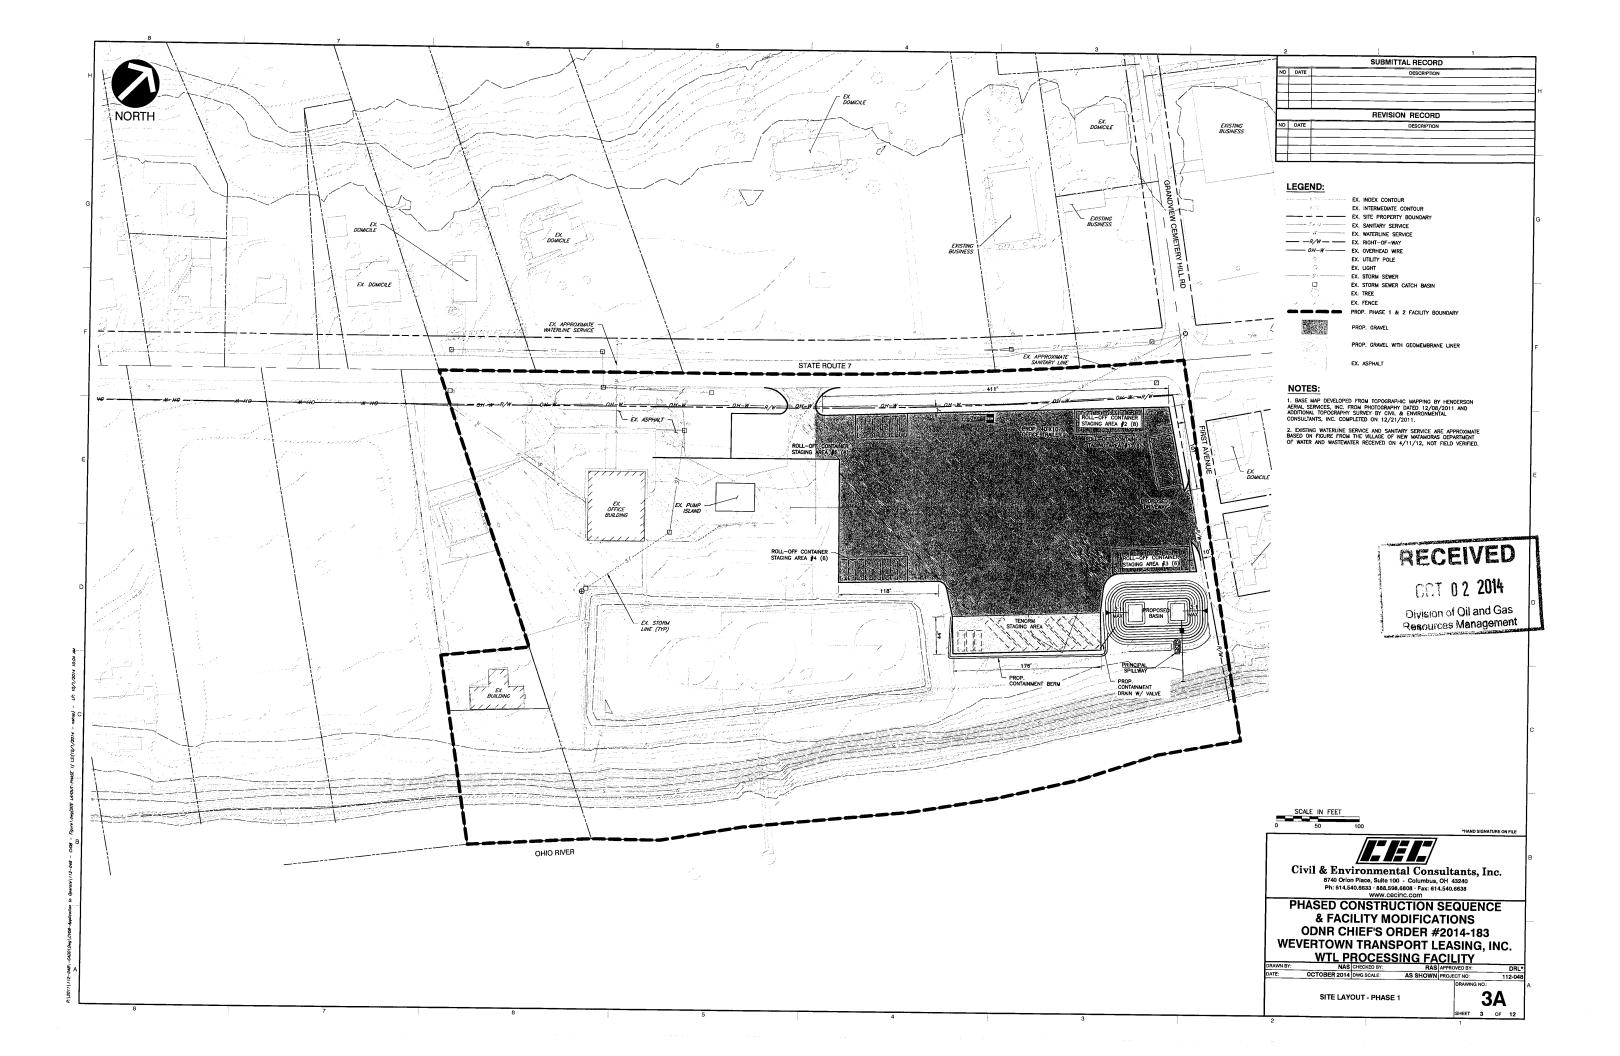


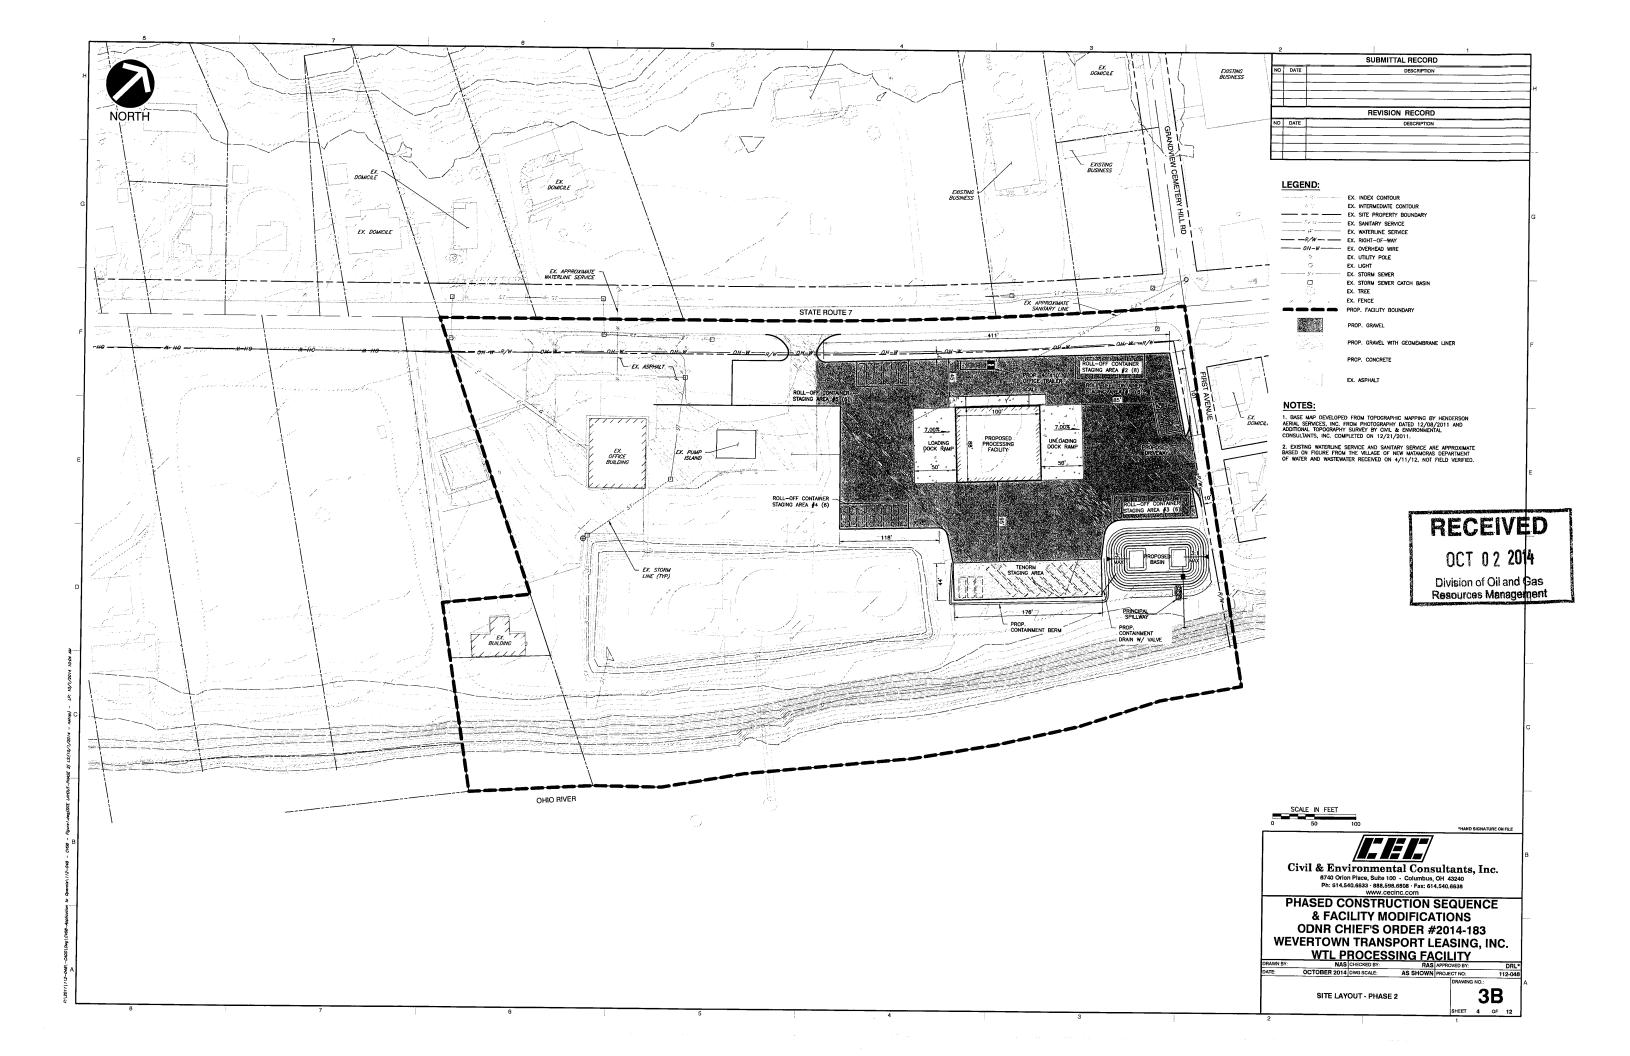

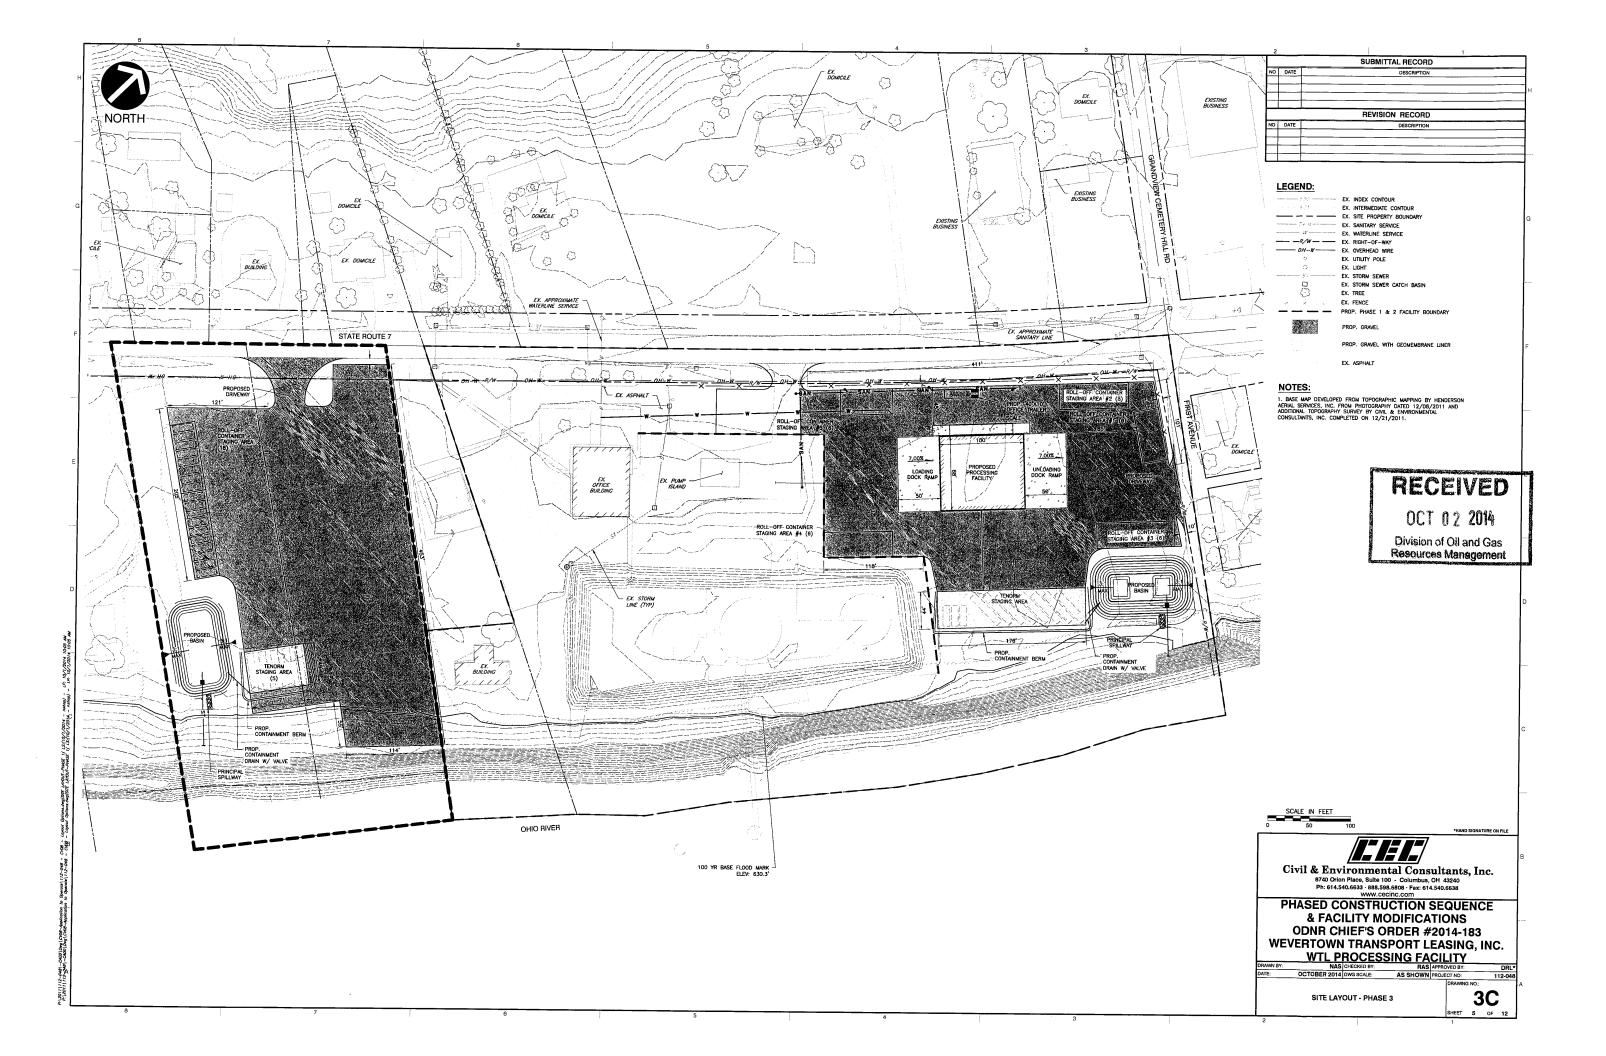

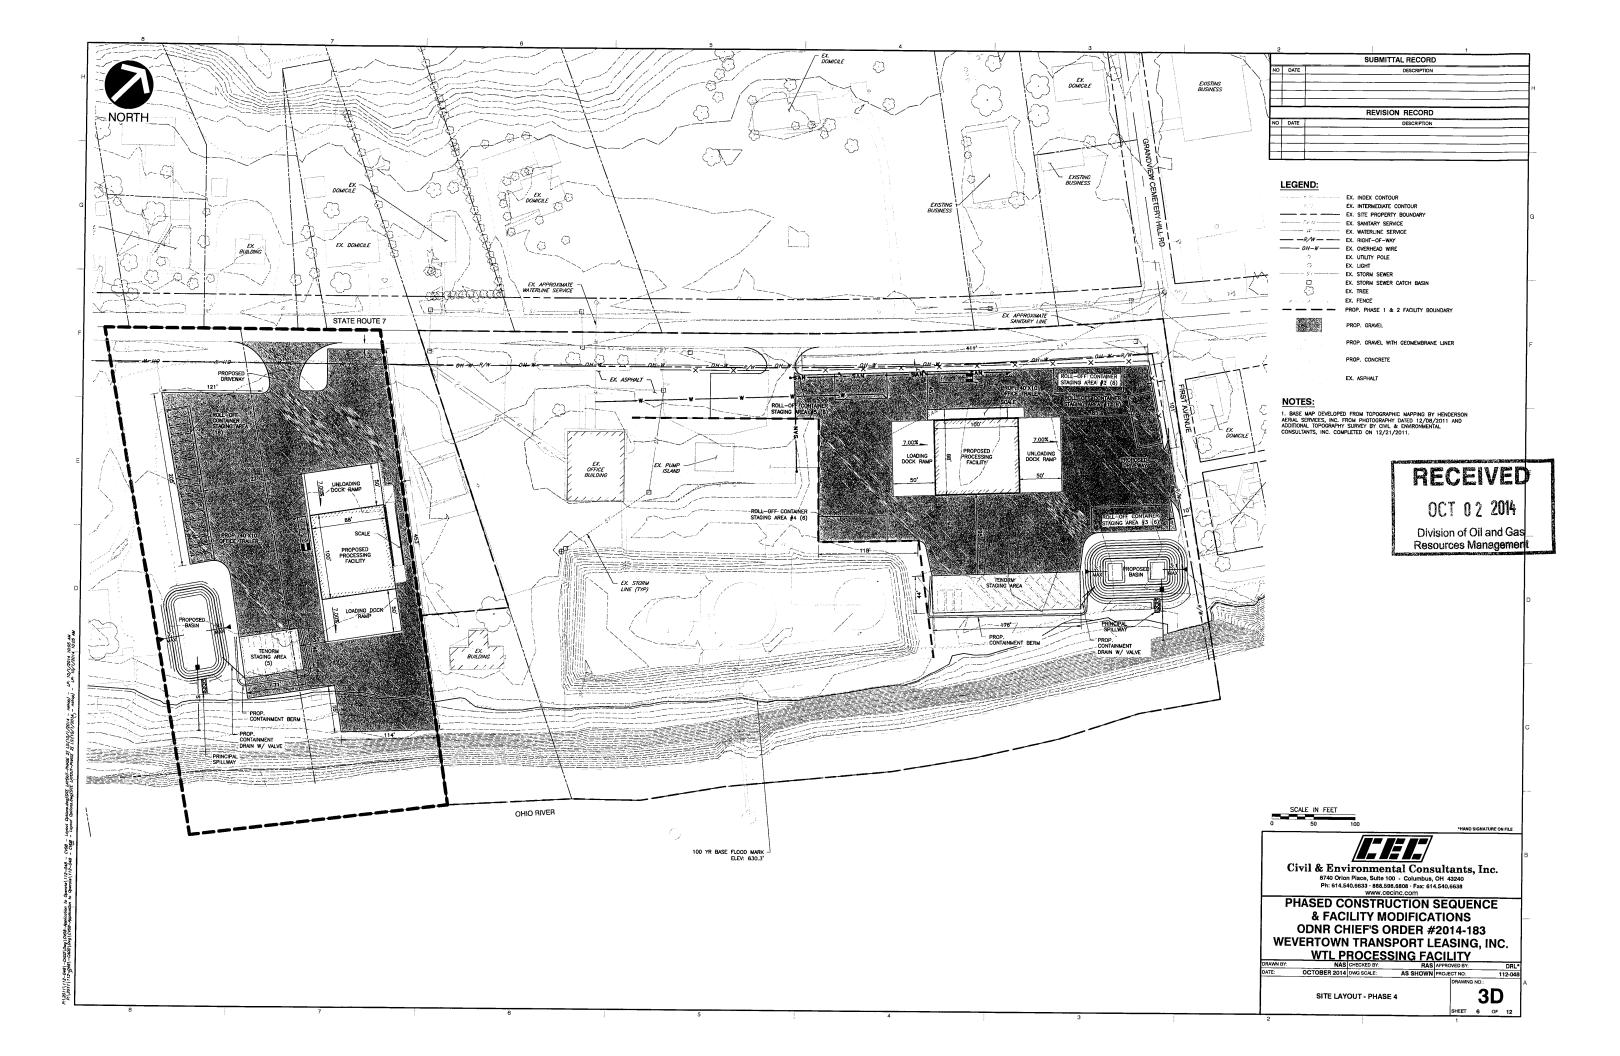

SUBMITTAL RECORD			
REVISION RECORD			SUBMITTAL RECORD
	NO	DATE	DESCRIPTION
	Н		
NO DATE DESCRIPTION	М	<u></u>	REVISION RECORD
	NO	DATE	DESCRIPTION
	$\vdash$		

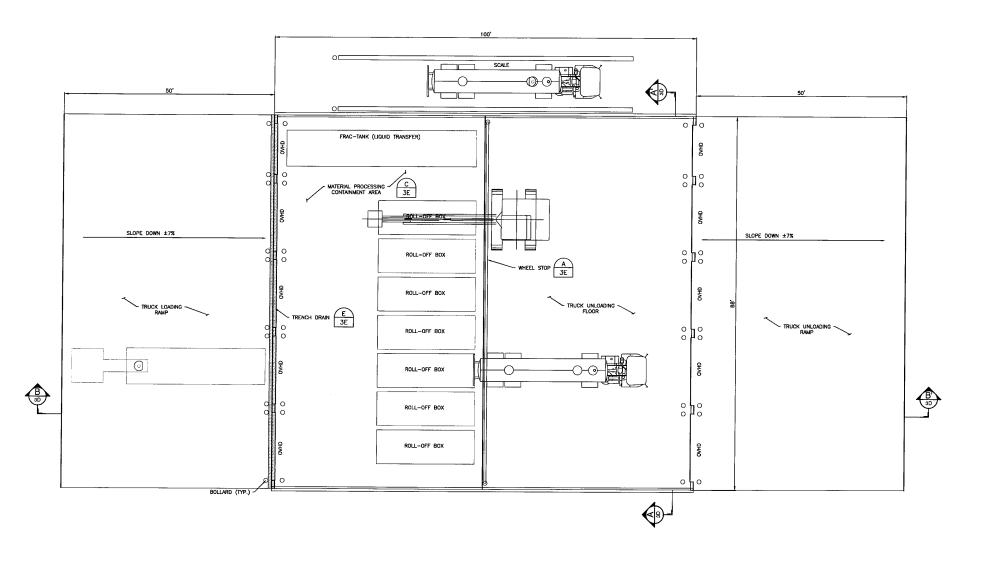

RECEIVED

OCT 02 2014

Division of Oil and Gas Resources Management

NOTE: BUILDING DIMENSIONS MAY VARY

Civil & Environmental Consultants, Inc.
8740 Orion Place, Suite 100 - Columbus, OH 43240
Ph: 614.540.6633 - 888.598.898 - Fax: 614.540.6638

PHASED CONSTRUCTION SEQUENCE & FACILITY MODIFICATIONS ODNR CHIEF'S ORDER #2014-183 WEVERTOWN TRANSPORT LEASING, INC. WTL PROCESSING FACILITY


NAS CHECKED BY: RAS APPROVED BY:
CTOBER 2014 DWG SCALE: AS SHOWN PROJECT NO:

OCTOBER 2014 DWG SCALE:


PROCESSING FACILITY BUILDING PLAN

3E

	SUBMITTAL RECORD				
<u> </u>	10	DATE	DESCRIPTION		
	_				
- ⊩	+			_	
⊢	+				
T			REVISION RECORD		
N	40	DATE	DESCRIPTION	~	
L					
L					

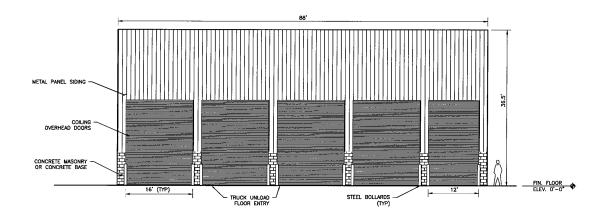

BUILDING ELEVATION A-A' SCALE: 1" = 10'
NOTE; BUILDING DIMENSIONS MAY VARY

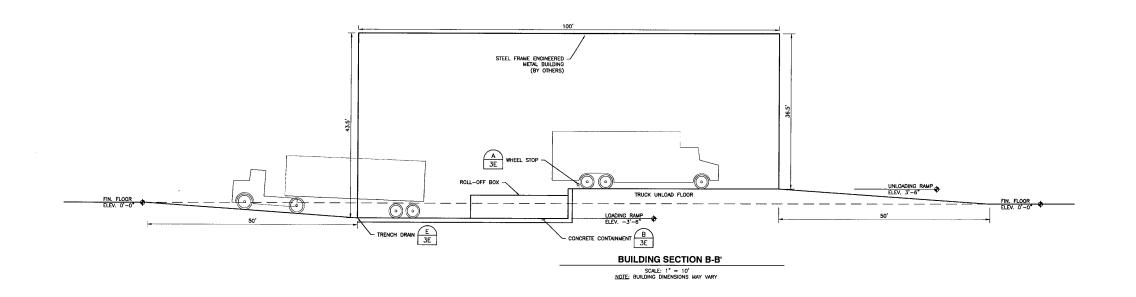

# RECEIVED

OCT 02 2014

Division of Oil and Gas Resources Management

Civil & Environmental Consultants, Inc. 8740 Orion Place, Sulte 100 - Columbus, OH 43240 Ph: 614.540.6633 - 888.598.6808 - Fax: 614.540.6638

PHASED CONSTRUCTION SEQUENCE
& FACILITY MODIFICATIONS
ODNR CHIEF'S ORDER #2014-183 WEVERTOWN TRANSPORT LEASING, INC.
WTL PROCESSING FACILITY

MAS COMPONENT BY BAS LABOROWED BY THE PROPERTY OF T

OCTOBER 2014 DWG SCALE:

PROCESSING FACILITY SECTION VIEWS

3F

### EROSION AND SEDIMENT CONTROL NOTES MANAGEMENT STRATEGIES AND SEQUENCE OF EROSION CONTROL MEASURES

UNLESS OTHERWISE INDICATED, ALL EROSION AND SEDIMENT CONTROL PRACTICES SHALL BE CONSTRUCTED AND MAINTAINED IN ACCORDANCE WITH THE REQUIREMENTS LISTED IN PART III OF THE MATOMAL POLLUTANT DISCHARGE ELIMINION SYSTEM (MPCES) GENERAL PERMIT NO. OFLODOOD FOR STORM WATER DISCHARGES ASSOCIATED WITH CONSTRUCTION ACTIVITY AS REGULATED BY THE OHIO EPA (GENERAL PERMIT).

IN THE EVENT OF CONFLICT BETWEEN THESE REQUIREMENTS AND POLLUTION CONTROL LAWS, RULES OR REGULATIONS OF OTHER FEDERAL OR STATE OR LOCAL AGENCIES, THE MORE RESTRICTIVE LAWS, RULES OR REGULATIONS SHALL APPLY.

THE FOLLOWING SEQUENCE OF EVENTS AND EROSION CONTROL MEASURES SHALL BE INCORPORATED INTO THE CONSTRUCTION SCHEDULE FOR THIS PROJECT AND SHALL APPLY TO ALL CONSTRUCTION ACTIVITIES WITHIN PROJECT LIMITS:

- TEMPORARY SEDIMENT TRAPS, SEDIMENT BARRIERS, AND EROSION CONTROL STONE ARE TO BE PLACED PRIOR TO CLEARING AND GRUBBING.
- EROSION CONTROL MEASURES ARE TO BE INSTALLED AND MADE OPERATIONAL AT THE START OF CLEARING OPERATIONS, INCLUDING APPROVED SEDIMENT BASINS.
- THE CONTRACTOR SHALL COMPLETE DRAINAGE FACILITIES WITHIN THIRTY (30) DAYS FOLLOWING COMPLETION OF ROUGH GRADING AT ANY POINT WITHIN THE PROJECT.
- CONSTRUCTION WILL BE SEQUENCED SO THAT GRADING OPERATIONS CAN BEGIN AND END AS QUICKLY AS POSSIBLE.
- AREAS WHICH ARE NOT TO BE DISTURBED WILL BE CLEARLY MARKED BY FENCING, FLAGS, SIGNS, ETC.
- A. PERMANENT OR TEMPORARY SOIL STABILIZATION SHALL BE APPLIED TO DENUDED AREAS WITHIN SEVEN (7) DAYS AFTER FINAL GRADE IS REACHED ON ANY PORTION OF THE SITE. TEMPORARY SOIL STABILIZATION SHALL BE APPLIED WITHIN SEVEN (7) DAYS TO DENUDED AREAS THAT MAY NOT BE AT FINAL GRADE BUT WILL REMAIN DOSMANT (UNDISTURBED) FOR LONGER THAN THIRTY (30) DAYS. PERMANENT STABILIZATION SHALL BE APPLIED TO AREAS THAT ARE TO BE LEFT DORMANT FOR MORE THAN ONE (1) YEAR.

C. A DERMANENT VECETATION COVER SHALL BE ESTABLISHED ON DENUDED AREAS NOT OTHERWISE. REPRIMAENTLY STABLIZED, PERMANENT VECETATION SHALL NOT BE CONSIDERED ESTABLISHED IMMAENT STABLIZED, PERMANENT FOR THE LOCAL PROGRAM ADMINISTRATION OF HIS DESIGNATED MEAT, IS UNFORM, MATURE ENOUGH TO SURVIVE AND WILL INHIBIT EROSION, VEGETAINE COVER SHALL BE ESTABLISHED AS FOLLOWS:

O. HYDRO SEEDING MAY BE USED IN PLACE OF MULCHING ON AREAS OTHER THAN DITCH BANKS). STABILIZATION MEASURES SHALL BE APPLIED TO EARTHEN STRUCTURES SUCH AS DAMS, DIVERSIONS, AND DITCHES OR WATERCOURSE BEDS AND BANKS IMMEDIATELY AFTER INSTALLATION.

- A CUT AND FILL SLOPES SHALL BE DESIGNED AND CONSTRUCTED IN A MANNER THAT WILL MINIMIZE EROSION. SLOPES THAT ARE FOUND TO BE ERODING EXCESSIVELY AS DETERMINED BY REGULATORY AGENCIES WITHIN ONE (1) YEAR OF PERMANENT STABILIZATION SHALL BE PROVIDED WITH ADDITIONAL SLOPE STABILIZING MEASURES UNTIL THE PROBLEM IS CORRECTED.

- ALL TEMPORARY EROSION AND SEDIMENT CONTROL MEASURES SHALL BE REMOVED WITHIN THIRTY (30) DAYS AFTER FINAL SITE STABILIZATION OR AFTER THE TEMPORARY MEASURES ARE NO LONGER NEEDED, UNESS OTHERWISE AUTHORIZED BY THE LOCAL PROGRAM ADMINISTRATOR. TRAPPED SEDIMENT AND DISTURBED SOIL AREAS RESULTING FROM THE DISPOSITION OF TEMPORARY MEASURES SHALL BE PERMANENTLY STABILIZED TO PREVENT FURTHER EROSION AND SEDIMENTATION.
- ALL STORM SEWER PIPES AND STRUCTURES ADJACENT TO THIS PROJECT SHALL BE CLEARED OF ALL DEBRIS AND ERODED MATERIAL UPON COMPLETION OF CONSTRUCTION

### DRAINAGE

THE COST OF STRUCTURE EXCAVATION FOR WINGWALLS OR HEADWALLS IS TO BE INCLUDED IN THE UNIT BID PRICE.

### **BENCHMARKS**

SCH 40 PIPE STUB SKIMMER-SECTION 

ALL JOINTS OF THE FLOTATION SECTION SHALL BE GLUED TOGETHER AND WATERTIGHT. JOINTS OF THE SKIMMER SECTION NEED NOT BE WATERTIGHT.

2. TO INSTALL DEWATERING PIPE STUB: FOR CORRUGATED METAL RISER, STUB SHALL BE SCH 40 STEEL PIPE TACK WELDED TO CREATE AMERICANT SEAL, FOR CONCRETE RISER, STUB SHALL BE SCH 40 PVC PIPE GROUTED TO CREATE WATERTIGHT SEAL

3. FLEXIBLE, NON-PERFORATED HDPE DRAIN PIPE SHALL BE ATTACHED TO OUTLET STRUCTURE DEWATERING STUB WITH WATERTICHT SEA!

ORIFICE TO BE SIZED FOR A MINIMUM 48-HOUR DEWATERING

### MAINTENANCE

N GENERAL, ALL EROSION AND SEDIMENTATION CONTROL MEASURES SHALL BE CHECKED AFTER FANIFALL OR WEEKLY, WHICKEVER IS MOST FREQUENT, AND SHOULD BE CLEANED AND REPAIRED ACCORDING TO THE FOLLOWING SCHEDULE:

- EROSION AND SEDIMENT CONTROL WILL BE CHECKED REGULARLY FOR UNDERMINING OR DETERIORATION AND BUILDUP OR CLOGGING WITH SEDIMENT. CORRECTIVE ACTION WILL BE TAKEN IMMEDIATELY.
- ALL SEEDED AREAS WILL BE CHECKED REGULARLY TO SEE THAT A GOOD STAND OF GRASS IS ESTABLISHED AND MAINTAINED. AREAS SHOULD BE FERTILIZED AND RESEEDED AS
- ALL TEMPORARY EROSION AND SEDIMENT MEASURES SHALL BE DISPOSED OF WITHIN THIRTY (30) DAYS AFTER FINAL SITE STABILIZATION IS ACHIEVED AND VEGETATION IS ESTABLISHED.
- TEMPORARY MODIFICATIONS TO STORMWATER POND USED FOR SEDIMENT CONTROL DURING CONSTRUCTION:

A. THE SEDIMENT POND AND OUTLET STRUCTURE SHALL BE CONSTRUCTED AND ALL TEMPORARY SEDIMENT CONTROL MODIFICATIONS SHALL BE OPERATIONAL BEFORE UPSLOPE LAND DISTURBANCE BEGINS.


C. DURING SITE CONSTRUCTION, SEDIMENT SHALL BE REMOVED WHEN THE SEDIMENT HAS FILLED ONE-HALF THE POND'S ORIGINAL DEPTH.

## WATER QUALITY


THE CONTRACTORS WILL BE RESPONSIBLE FOR WATER QUALITY THROUGHOUT THE DURATION OF CONSTRUCTION. THE ENVIRONMENTAL MONTOR AND/OR PROJECT ENGINEER WILL WORK CLOSELY WITH THE PROJECT SUPERVISOR. THE CONTRACTOR WILL BE RESPONSIBLE FOR THE FOLLOWING:


- DIRECTING THE CONSTRUCTION, OPERATION, AND DISMANTLING OF TEMPORARY EROSION CONTROL FEATURES.
- IMPLEMENTING REMEDIAL ACTION REQUIRED TO REPAIR FAILING EROSION AND SEDIMENTATION CONTROL FEATURES.
- SHAPE EARTHWORK PRIOR TO THE SUSPENSION OF GRADING OPERATIONS EACH DAY IN A MANNER THAT WILL PERMIT STORM RUNOFF WHILE MINIMIZING EROSION.
- EROSION CONTROL FEATURES INSTALLED BY THE CONTRACTOR WILL BE OPERATED AND MAINTAINED IN AN ACCEPTABLE CONDITION.


THE CONTRACTOR WILL BE REQUIRED TO PREPARE A SPILL PREVENTION, CONTROL, AND COUNTREMEASURES (SPPC) FLAN THAT ITEMZES SPECIFIC MEASURES THAT WILL BE IMPLEMENTED TO PREVENT AND CLEAN UP CHANGAL AND PETROLEMN PRODUCT SPILLS THAT MAY COCUR DURNIC ALL PHASES OF PROJECT CONSTRUCTION, FUEL STORAGE AND REFUELING ACTIVITIES, EQUIPMENT MANTENINGE ACTIVITIES, AND EQUIPMENT MASHING WILL BE KEPT AT LEAST 360 FEET AMAY FROM ANY PERCHAILA OR INTERMITTENT WATERCOURSE ON WEITLAND.

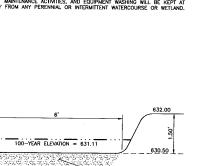




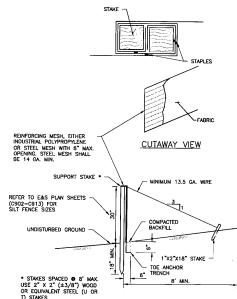


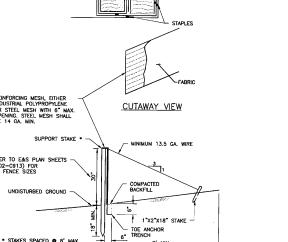

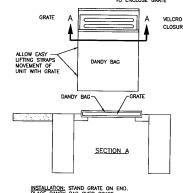



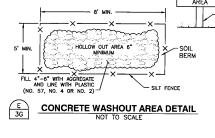

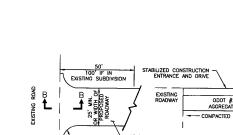

NOTE: THE EARTHWORK CONTRACTOR SHALL INSTALL AND MAINTAIN THE CONSTRUCTION ENTRANCE AND STAGING AREA. THE EARTHWORK CONTRACTOR SHALL PERIODICALLY ADD CLEAN STONE AND MAINTAIN THE GRAVEL EDGES FOR THE DURATION OF THE PRODUCT, WHEN THE CONSTRUCTION ENTRANCE AND DRIVE ARE NO LONGER NEEDED, THE EARTHWORK CONTRACTOR SHALL REMOVE THE GRAVEL AND RESTORE THE GROUND TO ITS ORIGINAL COMDITION.


G STABILIZED CONSTRUCTION ENTRANCE DETAIL NOT TO SCALE

III III.

Civil & Environmental Consultants, Inc. 8740 Orion Place, Suite 100 - Columbus, OH 43240 Ph: 614.540.6633 · 888.598.6808 · Fax: 614.540.6638

& FACILITY MODIFICATIONS ODNR CHIEF'S ORDER #2014-183 WEVERTOWN TRANSPORT LEASING, INC. WTL PROCESSING FACILITY

**EROSION CONTROL NOTES AND DETAILS** 

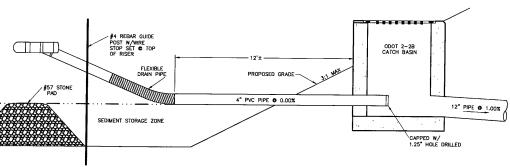

TEMPORARY SEDIMENT BASIN OUTLET DETAIL

NOT TO SCALE


- WATERTIGHT SEAL

SILT FENCE DETAIL

4" PVC 90" BEND

PERMANENT DETENTION BASIN OUTLET DETAIL

4" PVC PIPE @ 0.00% 12" PIPE @ 1.00% MICROPOOL CAPPED W/
1.25" HOLE DRILLED

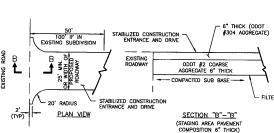

OCTOBER 2014 DWG SCALE

≺asources Management

RECEIVED

COT 02 2014

Division of Oil and Gas

CONCRETE WASHOUT AREA

SUBMITTAL RECORD

REVISION RECORD

PHASED CONSTRUCTION SEQUENCE

12 OF 12